THE HOUSING AUTHORITY OF HENRY COUNTY SHINGLE ROOFING REPLACEMENT

IL 9-1 FAIRVIEW APARTMENTS KEWANEE, IL

100 FAIRVIEW JUNCTION

CHIEF EXECUTIVE OFFICER

ANGELA HATHAWAY

JAN MAY

WALTER SIZEMORE

SECRETARY/TREASURER CAROL VANDEROSTYNE

COMMISSIONER

BOARD CHAIRMAN

VICE CHAIRPERSON

DAVID DYER

EDDIE TOLIVER II

COMMISSIONER

SCHEDULE OF DRAWINGS

GI.01 TITLE SHEET, LOCATION MAP, AND SCHEDULE OF DRAWINGS

A1.01 BUILDING K-1 ROOF PLANS

A1.02 BUILDING K-2 ROOF PLANS A1.03 BUILDING K-3 ROOF PLANS

A1.04 COMMUNITY BUILDING ROOF PLAN AND EXTERIOR ELEVATIONS

A2.01 BUILDING K-1 EXTERIOR ELEVATIONS

A2.02 BUILDING K-2 EXTERIOR ELEVATIONS

A2.03 BUILDING K-3 EXTERIOR ELEVATIONS

A5.01 DETAILS

A5.02 DETAILS

ARCHITECTURAL ABBREVIATIONS

<u> </u>		<u>JIML</u>	ADDILLI		
ACT	ACOUSTIC CEILING TILE	FD	FLOOR DRAIN	PREFIN	PREFINISHED
AFF	ABOVE FINISHED FLOOR	FE	FIRE EXTINGUISHER	PRV	POWER ROOF VENTILATOR
ALUM	ALUMINUM	FEC	FIRE EXTINGUISHER CABINET	PSF	POUNDS PER SQUARE FOOT
ASPH	ASPHALT	FH	FIRE HYDRANT	PSI	POUNDS PER SQUARE INCH
ASSY	ASSEMBLY	FHC	FIRE HOSE CABINET	PART	PARTITION
AUTO	AUTOMATIC	FHMS	FLAT HEAD MACHINE SCREW		
AVG	AVERAGE	FHWS	FLAT HEAD WOOD SCREW	PVC	POLYVINYL CHLORIDE
100	AVEIMOL			PVMT	PAVEMENT
		FIN	FINISH	QT	QUARRY TILE
BAL	BALANCE	FL	FLOOR	QI	QUARTET TILL
BC	BASE CABINET	FLSG	FLASHING	_	
BD	BOARD	FT	FOOT/FEET	R	RISER
BIT	BITUMINOUS	FTG	FOOTING	RAD	RADIUS
BLDG	BUILDING	110	1 0011110	RD	ROOF DRAIN
		0.4	0405	REF	REFERENCE
BLKG	BLOCKING	GA	GAGE	REFR	REFRIGERATOR
BM	BEAM	GALV	GALVANIZED	REINF	REINFORCING/REINFORCME
BOT	BOTTOM	GL	GLASS		
BSMT	BASEMENT	GR	GRADE	REQ	REQUIRED
BTW	BETWEEN	GR BM	GRADE BEAM	RM	ROOM
	2222	GWB	GYPSUM WALLBOARD	RO	ROUGH OPENING
CAD	CABINET				
CAB		GYP	GYPSUM	S	SOUTH
CAP	CAPACITY	НВ	HOSE BIBB		
CB	CATCH BASIN			SB	SINK BASE CABINET
CEM	CEMENT	HC	HOLLOW CORE	SC	SOLID CORE
CER	CERAMIC	HCBFH	UNIVERSAL ACCESS BASE	SCHED	SCHEDULE
CI	CAST IRON		W/FULL HEIGHT DOOR		
		HCCAR	UNIVERSAL ACCESS	SECT	SECTION
CJ	CONSTRUCTION JOINT		ROTATING CORNER BASE	SHT	SHEET
CL	CENTERLINE	HCDD		SH	SHOWER
CLG	CEILING	HCDB	UNIVERSAL ACCESS		
CLO	CLOSET		DRAWER BASE	SIM	SIMILAR
CLR	CLEAR	HDBD	HARDBOARD	SPEC	SPECIFICATION
		HDR	HEADER	SQ	SQUARE
CMU	CONCRETE MASONRY UNIT	HDWD	HARDWOOD		
COL	COLUMN	HM	HOLLOW METAL	SQ FT	SQUARE FOOT
CONC	CONCRETE			SS	SERVICE SINK
CONF	CONFERENCE	HORIZ	HORIZONTAL	S/S	STAINLESS STEEL
CONN	CONNECTION	HGT	HEIGHT	ST	STREET
CONSTR	CONSTRUCTION	HVAC	HEATING, VENTILATING		
CONT	CONTINUOUS		& AIR CONDITIONING	STA	STATION
		HYD	HYDRANT	STD	STANDARD
CONTR	CONTRACTOR	2		STL	STEEL
CT	CERAMIC TILE	ID	INCIDE DIAMETED		
CTSK	COUNTERSINK	ID 	INSIDE DIAMETER	STOR	STORAGE
CWC	CORNER WALL CABINET	IN	INCHES	STR	STRUCTURAL/STRUCTURE
CWS	CORNER WALL CABINET	INSUL	INSULATION	SUSP	SUSPENDED
	WITH LAZY SUSAN	INT	INTERIOR	0001	0001 211925
	WITH LAZT SUSAN	MAINT	MAINTENANCE		
		MATL	MATERIAL	T&B	TOP AND BOTTOM
d	PENNY (NAIL)	MAX	MAXIMUM	T&G	TONGUE AND GROVE
OB	DRAWER BASE CABINET			TB	TACKBOARD
OBL	DOUBLE	MECH	MECHANICAL		
DEG	DEGREE	MEMB	MEMBRANE	TC	TOP OF CONCRETE
DF	DRINKING FOUNTAIN	MEZZ	MEZZANINE	TEMP	TEMPERATURE
		MFR	MANUFACTURER	TS	TOP OF STEEL
DIA	DIAMETER	MIN	MINIMUM		
DIFF	DIFFUSER			THK	THICK/THICKNESS
DIM	DIMENSION	MISC	MISCELLANEOUS		
DL	DEAD LOAD	MO	MASONRY OPENING	UNFIN	UNFINISHED
DN	DOWN	MR	MOISTURE RESISTANT	UR	URINAL
OR .	DOOR	MSNRY	MASONRY	UK	URINAL
		MTG	MOUNTING		
OS	DOWN SPOUT	MTL	METAL	V	VENT, VOLT
DTL	DETAIL	MUL	MULLION	VCT	VINYL COMPOSITION TILE
		WUL	MULLION		
				VENT	VENTILATION
Ē	EAST	N/A	NOT APPLICABLE	VERT	VERTICAL
EA	EACH	(N)	NEW		
		N	NORTH	147	14/507
EB	EXPANSION BOLT	NIC	NOT IN CONTRACT	W	WEST
EJ	EXPANSION JOINT			W/	WITH
ELEV	ELEVATION	No.	NUMBER	W/O	WITHOUT
ELECT	ELECTRIC	NOM	NOMINAL		
ENCL	ENCLOSURE	NTS	NOT TO SCALE	WC	WATER CLOSET
ENTR	ENTRANCE			W.C.	WALL CABINET
		OBS	OBSCURE	WD	WOOD
EQ	EQUAL				
EQPT	EQUIPMENT	00	ON CENTER	WGL	WIRE GLASS
EWC	ELECTRIC WATER COOLER	OD	OUTSIDE DIAMETER	WM	WIRE MESH
EXP	EXPANSION	OPP	OPPOSITE	WP	WEATHERPROOF
	EXISTING				
EX)		P LAM	PLASTIC LAMINATE	WWF	WELDED WIRE FABRIC
EXT	EXTERIOR				VARR
		PERF	PERFORATED	YD	YARD
		PL GL	PLATE GLASS		
		PLMB	PLUMBING		
		PLYWD	PLYWOOD		
		POL	POLISHED		
		PR	PAIR		

PROJECT NUMBERS

IL9-1 FAIRVIEW APARTMENTS

KEWANEE, ILLINOIS

CONTRACTOR

PROJECT NUMBER:

ALL CONTRACTORS

IL9-1 LOCATION MAP

NOTE: ALL CONTRACTORS SHALL FIELD VERIFY ALL DIMENSIONS AND CONDITIONS AT ALL ITEMS OF WORK.

DETAIL/SECTION REFERENCES DETAIL OR —

SECTION NUMBER SHEET NUMBER ON WHICH DETAIL OR SECTION IS SHOWN



IT IS HEREBY CERTIFIED THAT THESE DOCUMENTS WERE PREPARED UNDER OUR DIRECT SUPERVISION AND CONTROL, IN OUR OFFICE, AND TO THE BEST OF OUR KNOWLEDGE THEY COMPLY WITH ALL STATE, COUNTY AND MUNICIPAL CODES AND ORDINANCES FOR HEALTH, SAFETY AND ENVIRONMENTAL BARRIER ACT REGULATIONS.

ILLINOIS PROFESSIONAL DESIGN FIRM LICENSE NUMBER 184-000299 LICENSE EXPIRATION DATE: APRIL 30, 2023

BY: MICHAEL S. KMETZ II, A.I.A ILLINOIS LICENSE NUMBER 001-015908 LICENSE EXPIRATION DATE: NOVEMBER 30, 2022 DATE: ____



BID SET

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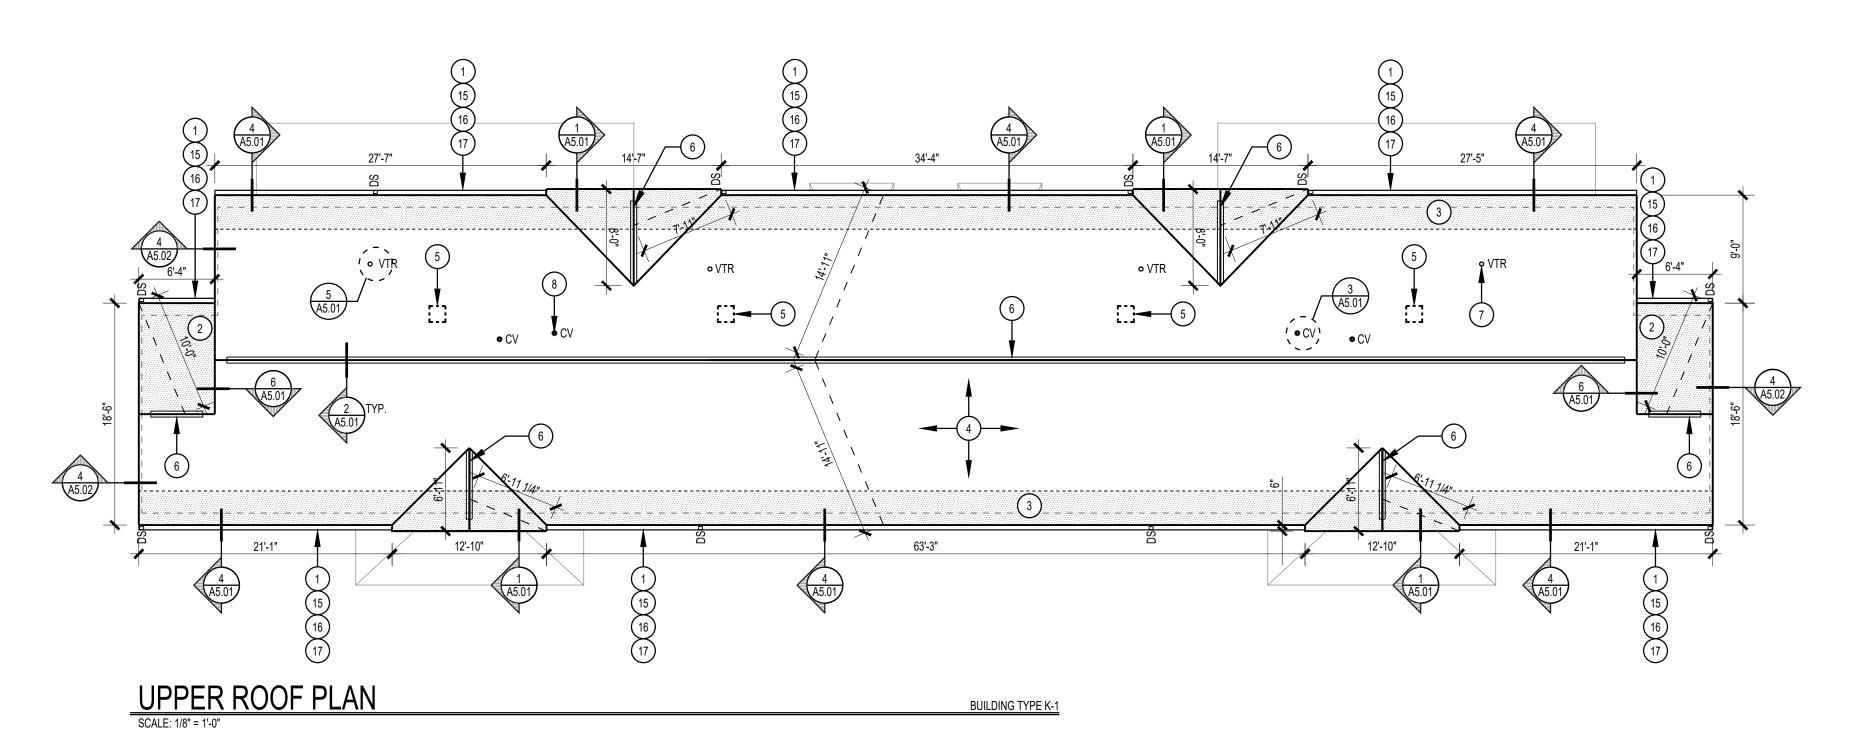
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DESCRIPTION TITLE SHEET

SHEET NO.

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G1.01



GENERAL ROOFING WORK NOTES

- REMOVE EXISTING SHINGLE ROOFING AND FELT UNDERLAYMENT DOWN TO WOOD ROOF SHEATHING
- 2. REMOVE EXISTING LOW SLOPE ROOFING TO WOOD DECK.
- 3. REMOVE EXISTING ROOF VENTILATORS.
- 4. REMOVE EXISTING VENT STACK FLASHINGS AND DISPOSE OF OFF SITE
- 5. REMOVE EXISTING FLUE FLASHINGS, RETAIN PIPING AND CAPS FOR REUSE.
- 6. REMOVE EXISTING CONCENTRIC VENT FLASHINGS.
- REMOVE EXISTING ROOF EDGE FLASHINGS AND GUTTER APRON AND DISPOSE OF OFF SITE
- 8. SALVAGE EXISTING GUTTERS AND DOWNSPOUTS FOR REUSE.
- 9. REMOVE AND REINSTALL SIDING AS REQUIRED FOR FLASHING INSTALLATION.
- 10. PROVIDE NEW SHINGLE ROOFING, UNDERLAYMENT, FLASHINGS AND ACCESSORIES AS DETAILED AND SPECIFIED
- 11. PROVIDE NEW LOW SLOPE ROOFING, TAPERED INSULATION, FLASHINGS, AND ACCESSORIES AS DETAILED AND SPECIFIED.
- 12. REINSTALL SALVAGED GUTTERS AND DOWNSPOUTS.
- 13. REMOVE ALL CONSTRUCTION DEBRIS FROM SITE AT THE END OF EACH DAY, STORE DEBRIS IN ON SITE CONTAINERS UNTIL READY TO REMOVE TO LANDFILL

ROOFING WORK KEYNOTES


- REINSTALL SALVAGED GUTTERS AND DOWNSPOUTS
- PROVIDE NEW SHINGLES OVER SELF ADHERING SHEET UNDERLAYMENT TO LIMITS OF SHADING
- PROVIDE SELF ADHERING SHEET UNDERLAYMENT TO 24" INSIDE THE EXTERIOR WALL LINE, SHOWN HATCHED.
- 4 NEW SHINGLE ROOFING AND UNDERLAYMENT AS SPECIFIED.
- 5 INFILL ABANDONED VENTILATOR OPENING WITH PLYWOOD TO MATCH EXISTING THICKNESS, PROVIDE BLOCKING AT UNSUPPORTED EDGES.
- 6 PROVIDE NEW CONTINUOUS RIDGE VENT AS SPECIFIED
- 7 PROVIDE NEW LEAD FLASHING AT VTR, FIELD VERIFY SIZE, TYPICAL.
- 8 PROVIDE NEW FLASHING AT CONCENTRIC VENT, FIELD VERIFY SIZE, TYPICAL.
- 9 PROVIDE 7' LONG PREFINISHED METAL DIVERTER, CENTER AT DOORS.
- 10) PROVIDE 3'-6" LONG PREFINISHED METAL DIVERTER, CENTER ON DOOR.
- (11) SELF ADHERING SHEET UNDERLAYMENT, EXTEND 24" OUT FROM WALL LINE.
- 12 NEW EPDM LOW SLOPE ROOFING AS SPECIFIED.
- PROVIDE PREFINISHED METAL FLASHING SHINGLES AT ROOF OFFSET. VERTICAL LEG SHALL EXTEND TO UPPER ROOF SURFACE, SEE DETAIL 10/5.01.
- ROOF TRANSITIONS FROM 5:12 TO 2:12 AT THIS LINE.
- 15) ALTERNATE BID NO 1: PROVIDE NEW GUTTERS AND DOWNSPOLITS
- ALTERNATE BID NO.2: PROVIDE GUTTER GUARD SYSTEM AS SPECIFIED IN EXISTING GUTTER.
- 17) ALTERNATE BID NO.3: PROVIDE GUTTER GUARD SYSTEM AS SPECIFIED IN NEW GUTTER.


ROOF PLAN SYMBOLS

O VTR PLUMBING VENT THROUGH ROOF, VERIFY SIZE

POWERED ROOF EXHAUSTER

- CV CONCENTRIC VENT, VERIFY SIZE
- GV GAS VENT (FLUE)
- DOWNSPOUT

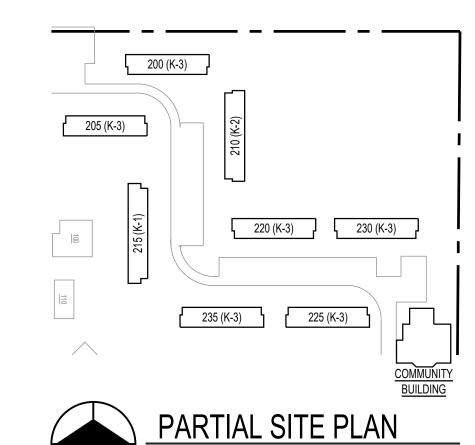

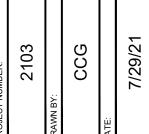

HOUSING AUTHORITY OF HENRY COUNT SHINGLE ROOFING REPLACEMENT IL9-1 FAIRVIEW APARTMENTS, KEWANEE, IL


SHEET NO.

DESCRIPTION

BUILDING K-1 ROOF PLANS

A1.01

OF

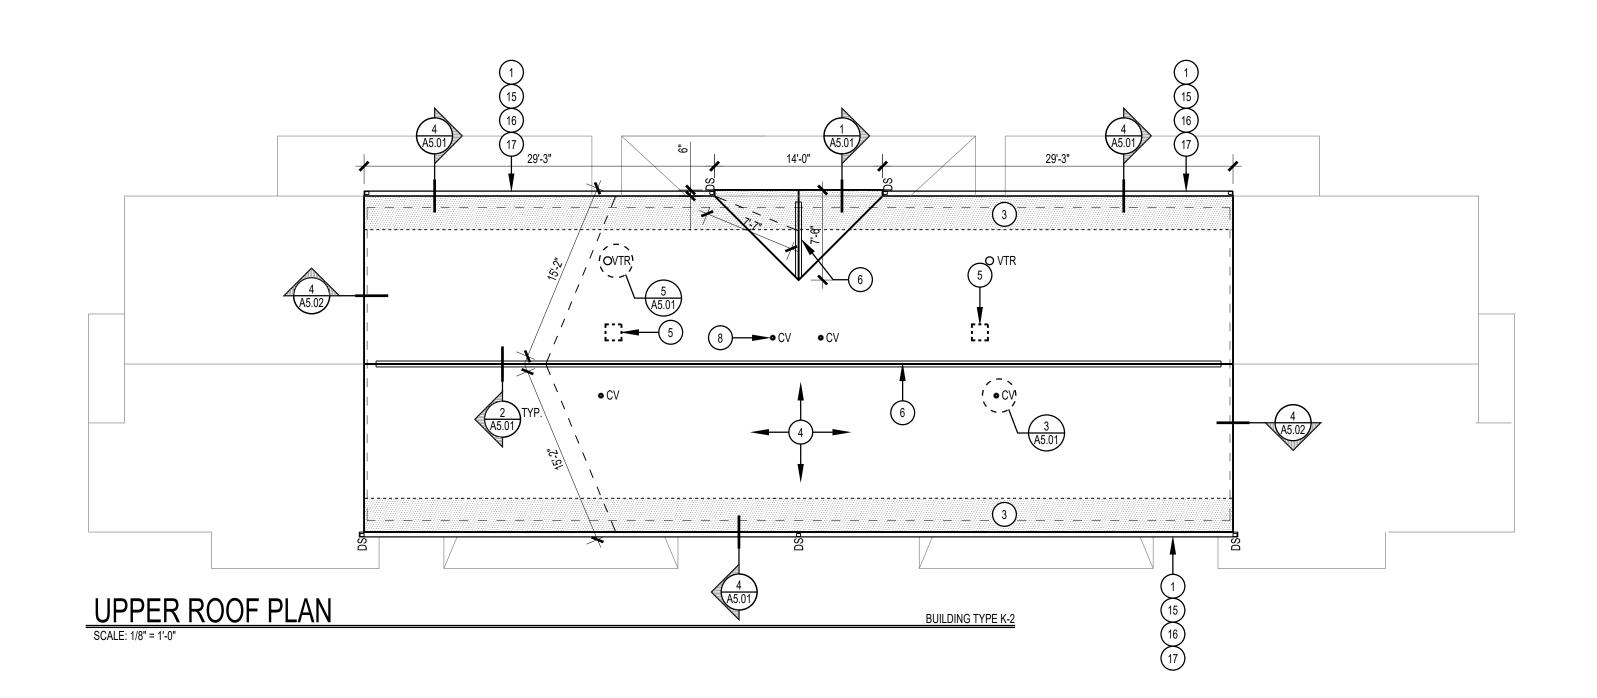

GENERAL ROOFING WORK NOTES


- 1. REMOVE EXISTING SHINGLE ROOFING AND FELT UNDERLAYMENT DOWN TO WOOD ROOF SHEATHING
- 2. REMOVE EXISTING LOW SLOPE ROOFING TO WOOD DECK.
- REMOVE EXISTING ROOF VENTILATORS.
- 4. REMOVE EXISTING VENT STACK FLASHINGS AND DISPOSE OF OFF SITE
- 5. REMOVE EXISTING FLUE FLASHINGS, RETAIN PIPING AND CAPS FOR REUSE.
- REMOVE EXISTING CONCENTRIC VENT FLASHINGS.
- 7. REMOVE EXISTING ROOF EDGE FLASHINGS AND GUTTER APRON AND DISPOSE OF
- 8. SALVAGE EXISTING GUTTERS AND DOWNSPOUTS FOR REUSE.
- 9. REMOVE AND REINSTALL SIDING AS REQUIRED FOR FLASHING INSTALLATION.
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- 12. REINSTALL SALVAGED GUTTERS AND DOWNSPOUTS.
- 13. REMOVE ALL CONSTRUCTION DEBRIS FROM SITE AT THE END OF EACH DAY, STORE DEBRIS IN ON SITE CONTAINERS UNTIL READY TO REMOVE TO LANDFILL


ROOFING WORK KEYNOTES

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- 2 PROVIDE NEW SHINGLES OVER SELF ADHERING SHEET UNDERLAYMENT TO LIMITS OF SHADING
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- 5 INFILL ABANDONED VENTILATOR OPENING WITH PLYWOOD TO MATCH EXISTING THICKNESS, PROVIDE BLOCKING AT UNSUPPORTED EDGES.
- 6 PROVIDE NEW CONTINUOUS RIDGE VENT AS SPECIFIED
- 7 PROVIDE NEW LEAD FLASHING AT VTR, FIELD VERIFY SIZE, TYPICAL.
- (8) PROVIDE NEW FLASHING AT CONCENTRIC VENT, FIELD VERIFY SIZE, TYPICAL.
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- 10 PROVIDE 3'-6" LONG PREFINISHED METAL DIVERTER, CENTER ON DOOR.
- 11) SELF ADHERING SHEET UNDERLAYMENT, EXTEND 24" OUT FROM WALL LINE.
- 12) NEW EPDM LOW SLOPE ROOFING AS SPECIFIED.
- PROVIDE PREFINISHED METAL FLASHING SHINGLES AT ROOF OFFSET. VERTICAL LEG
- ROOF TRANSITIONS FROM 5:12 TO 2:12 AT THIS LINE.
- 15 <u>ALTERNATE BID NO.1:</u> PROVIDE NEW GUTTERS AND DOWNSPOUTS AS SPECIFIED.
- ALTERNATE BID NO.2: PROVIDE GUTTER GUARD SYSTEM AS SPECIFIED IN EXISTING GUTTER.
- 17 ALTERNATE BID NO.3: PROVIDE GUTTER GUARD SYSTEM AS SPECIFIED IN NEW GUTTER.

ROOF PLAN SYMBOLS

- O VTR PLUMBING VENT THROUGH ROOF, VERIFY SIZE
- CV CONCENTRIC VENT, VERIFY SIZE
- GAS VENT (FLUE) DOWNSPOUT
- POWERED ROOF EXHAUSTER

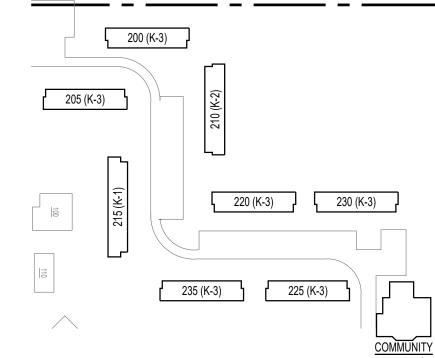

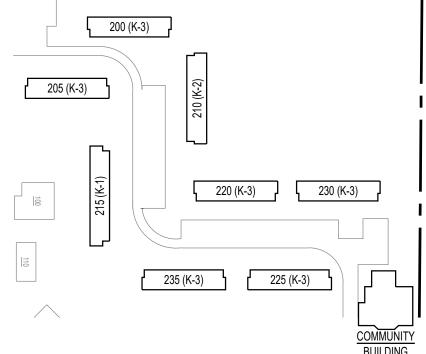

PARTIAL SITE PLAN

A1.02

SHEET NO.

DESCRIPTION

BUILDING K-2 ROOF PLANS

OF



FHORITY OF HENRY COUNROPING REPLACEMENT IL9-1 FAIRVIEW APARTMENTS, KEWANEE, IL OF HENRY AUTHORITY SHINGLE HOUSING

8. SALVAGE EXISTING GUTTERS AND DOWNSPOUTS FOR REUSE. 9. REMOVE AND REINSTALL SIDING AS REQUIRED FOR FLASHING INSTALLATION.

10. PROVIDE NEW SHINGLE ROOFING, UNDERLAYMENT, FLASHINGS AND ACCESSORIES AS DETAILED AND SPECIFIED

11. PROVIDE NEW LOW SLOPE ROOFING, TAPERED INSULATION, FLASHINGS, AND ACCESSORIES AS DETAILED AND SPECIFIED.

12. REINSTALL SALVAGED GUTTERS AND DOWNSPOUTS.

13. REMOVE ALL CONSTRUCTION DEBRIS FROM SITE AT THE END OF EACH DAY, STORE DEBRIS IN ON SITE CONTAINERS UNTIL READY TO REMOVE TO LANDFILL

ROOFING WORK KEYNOTES

REINSTALL SALVAGED GUTTERS AND DOWNSPOUTS

2 PROVIDE NEW SHINGLES OVER SELF ADHERING SHEET UNDERLAYMENT TO LIMITS OF SHADING

PROVIDE SELF ADHERING SHEET UNDERLAYMENT TO 24" INSIDE THE EXTERIOR WALL LINE, SHOWN HATCHED.

4 NEW SHINGLE ROOFING AND UNDERLAYMENT AS SPECIFIED.

5 INFILL ABANDONED VENTILATOR OPENING WITH PLYWOOD TO MATCH EXISTING THICKNESS, PROVIDE BLOCKING AT UNSUPPORTED EDGES.

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11) SELF ADHERING SHEET UNDERLAYMENT, EXTEND 24" OUT FROM WALL LINE.

12) NEW EPDM LOW SLOPE ROOFING AS SPECIFIED.

PROVIDE PREFINISHED METAL FLASHING SHINGLES AT ROOF OFFSET. VERTICAL LEG SHALL EXTEND TO UPPER ROOF SURFACE, SEE DETAIL 10/5.01.

ROOF TRANSITIONS FROM 5:12 TO 2:12 AT THIS LINE.

15 ALTERNATE BID NO.1: PROVIDE NEW GUTTERS AND DOWNSPOUTS AS SPECIFIED.

16 ALTERNATE BID NO.2: PROVIDE GUTTER GUARD SYSTEM AS SPECIFIED IN EXISTING GUTTER.


17) ALTERNATE BID NO.3: PROVIDE GUTTER GUARD SYSTEM AS SPECIFIED IN NEW GUTTER.


ROOF PLAN SYMBOLS

O VTR PLUMBING VENT THROUGH ROOF, VERIFY SIZE

• CV CONCENTRIC VENT, VERIFY SIZE

POWERED ROOF EXHAUSTER

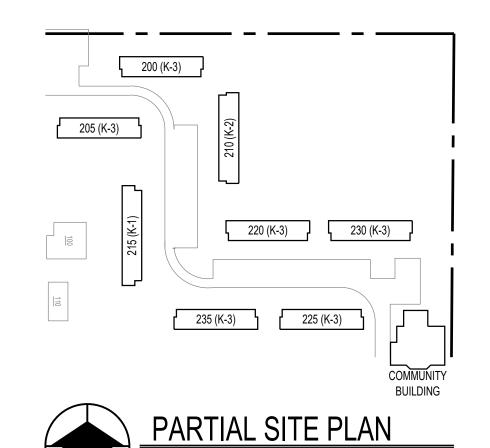

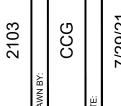

HOUSING AUTHORITY OF HENRY COUN SHINGLE ROOFING REPLACEMENT IL9-1 FAIRVIEW APARTMENTS, KEWANEE, IL


DESCRIPTION

BUILDING K-3 ROOF PLANS

SHEET NO.

A1.03

OF

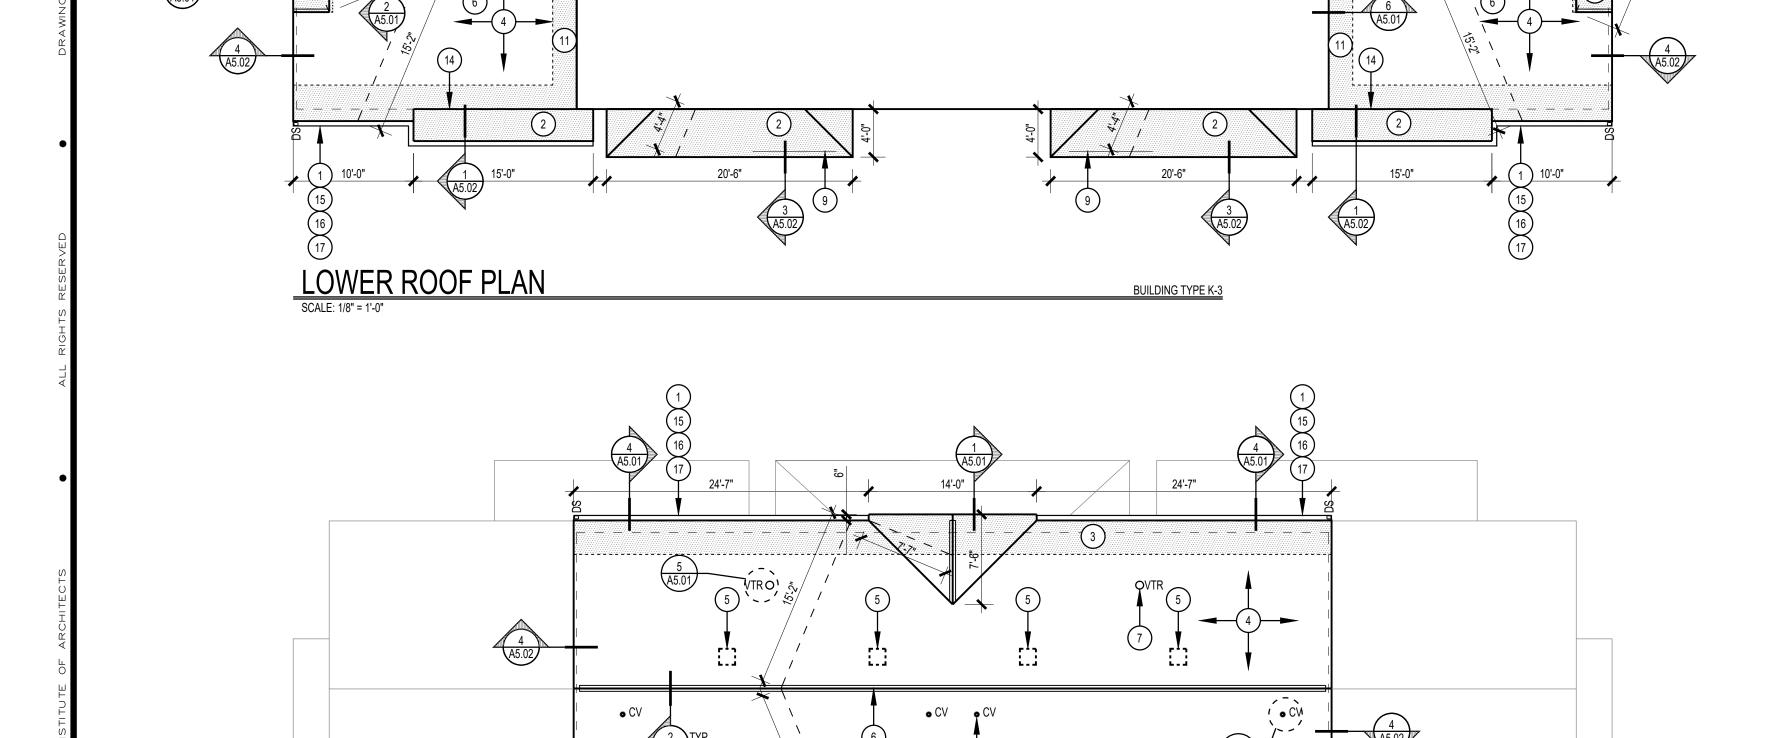

BUILDING TYPE K-3

1 15 16 15

UPPER ROOF PLAN


SCALE: 1/8" = 1'-0"


COMMUNITY
BUILDING
ROOF PLAN
AND
EXTERIOR
ELEVATIONS

SHEET NO.

A1.04

OF

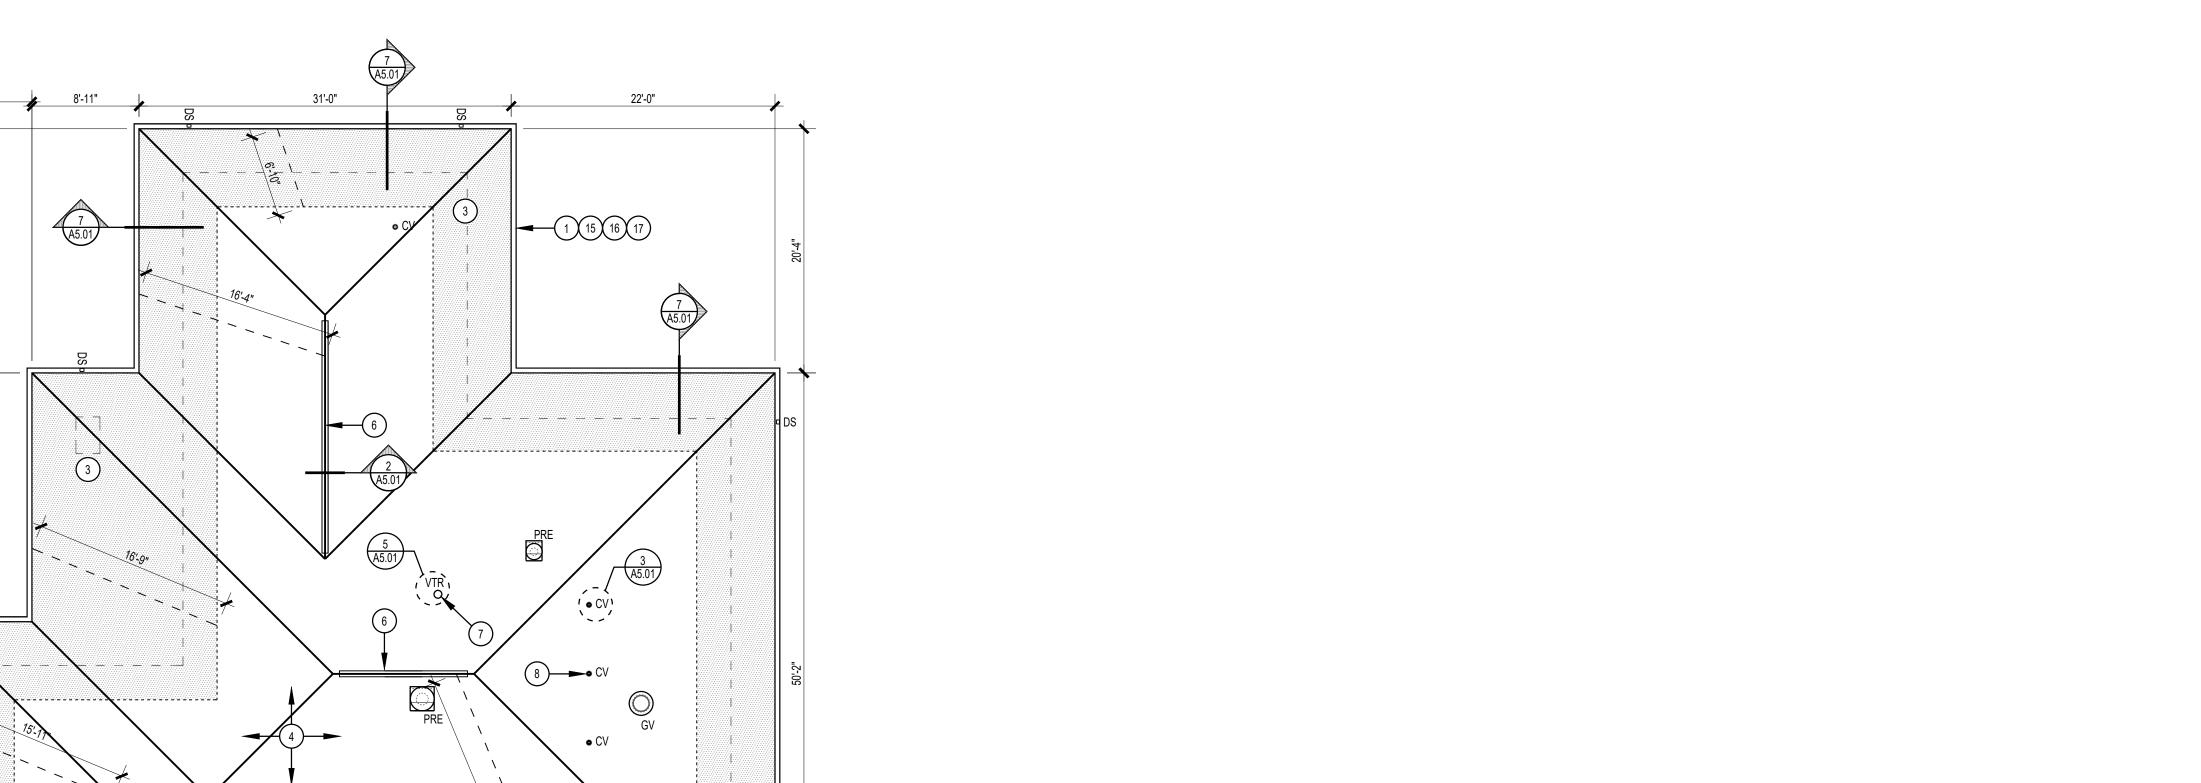


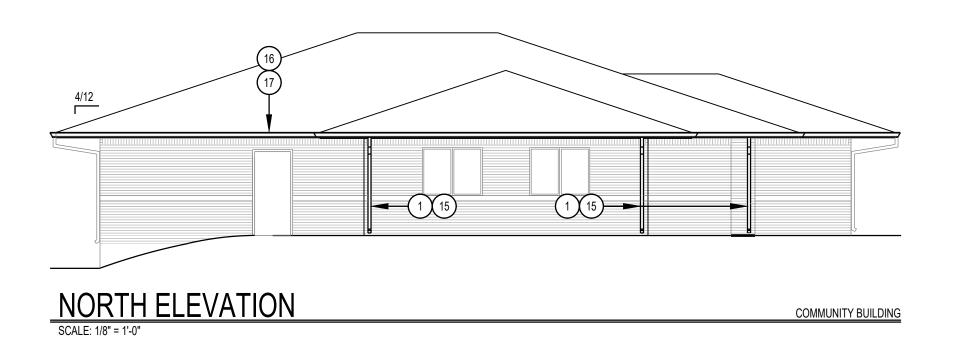


ROOF PLAN

SCALE: 1/8" = 1'-0"

18'-3"

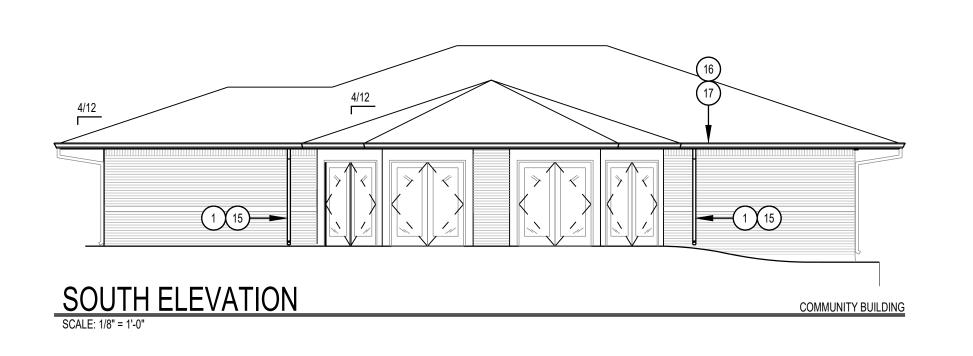


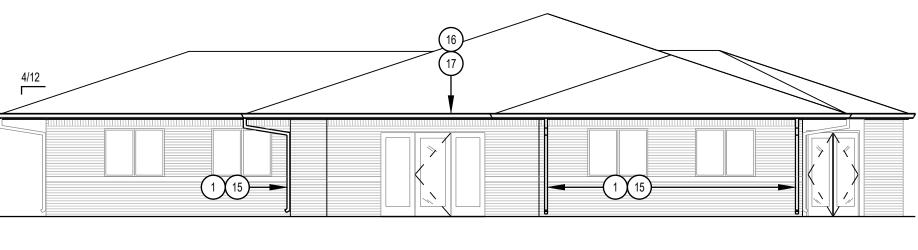

WEST ELEVATION

SCALE: 1/8" = 1'-0"

COMMUNITY BUILDING

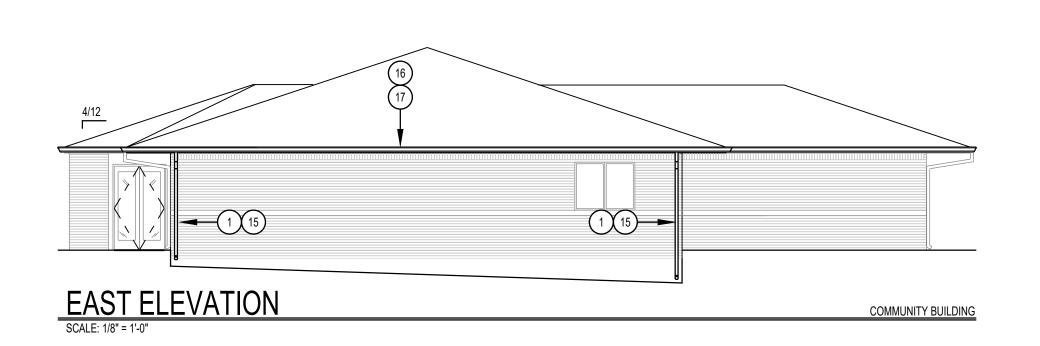

12. REINSTALL SALVAGED GUTTERS AND DOWNSPOUTS. 13. REMOVE ALL CONSTRUCTION DEBRIS FROM SITE AT THE END OF EACH DAY, STORE DEBRIS IN ON SITE CONTAINERS UNTIL READY TO REMOVE TO LANDFILL

ACCESSORIES AS DETAILED AND SPECIFIED.

ROOFING WORK KEYNOTES

- REINSTALL SALVAGED GUTTERS AND DOWNSPOUTS
- 2 PROVIDE NEW SHINGLES OVER SELF ADHERING SHEET UNDERLAYMENT TO LIMITS OF SHADING

GENERAL ROOFING WORK NOTES

1. REMOVE EXISTING SHINGLE ROOFING AND FELT UNDERLAYMENT DOWN TO WOOD

REMOVE EXISTING LOW SLOPE ROOFING TO WOOD DECK.

6. REMOVE EXISTING CONCENTRIC VENT FLASHINGS.

8. SALVAGE EXISTING GUTTERS AND DOWNSPOUTS FOR REUSE.

4. REMOVE EXISTING VENT STACK FLASHINGS AND DISPOSE OF OFF SITE

5. REMOVE EXISTING FLUE FLASHINGS, RETAIN PIPING AND CAPS FOR REUSE.

7. REMOVE EXISTING ROOF EDGE FLASHINGS AND GUTTER APRON AND DISPOSE OF

9. REMOVE AND REINSTALL SIDING AS REQUIRED FOR FLASHING INSTALLATION.

11. PROVIDE NEW LOW SLOPE ROOFING, TAPERED INSULATION, FLASHINGS, AND

10. PROVIDE NEW SHINGLE ROOFING, UNDERLAYMENT, FLASHINGS AND ACCESSORIES AS

ROOF SHEATHING

OFF SITE


REMOVE EXISTING ROOF VENTILATORS.

DETAILED AND SPECIFIED

- PROVIDE SELF ADHERING SHEET UNDERLAYMENT TO 24" INSIDE THE EXTERIOR WALL LINE, SHOWN HATCHED.
- 4 NEW SHINGLE ROOFING AND UNDERLAYMENT AS SPECIFIED.
- 5 INFILL ABANDONED VENTILATOR OPENING WITH PLYWOOD TO MATCH EXISTING THICKNESS, PROVIDE BLOCKING AT UNSUPPORTED EDGES.
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ROOF PLAN SYMBOLS

- O VTR PLUMBING VENT THROUGH ROOF, VERIFY SIZE
- CV CONCENTRIC VENT, VERIFY SIZE
- GAS VENT (FLUE)
- DS DOWNSPOUT
- POWERED ROOF EXHAUSTER

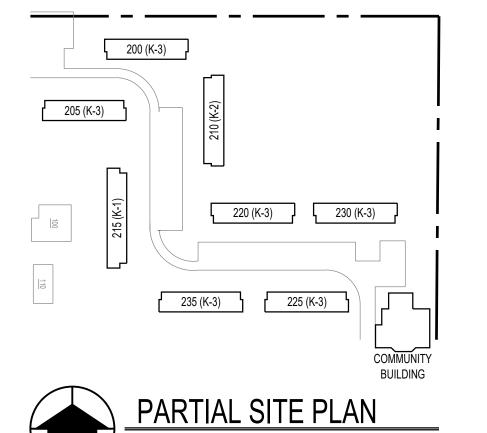


DESCRIPTION


BUILDING K-1 EXTERIOR ELEVATIONS


SHEET NO.


A2.01

OF

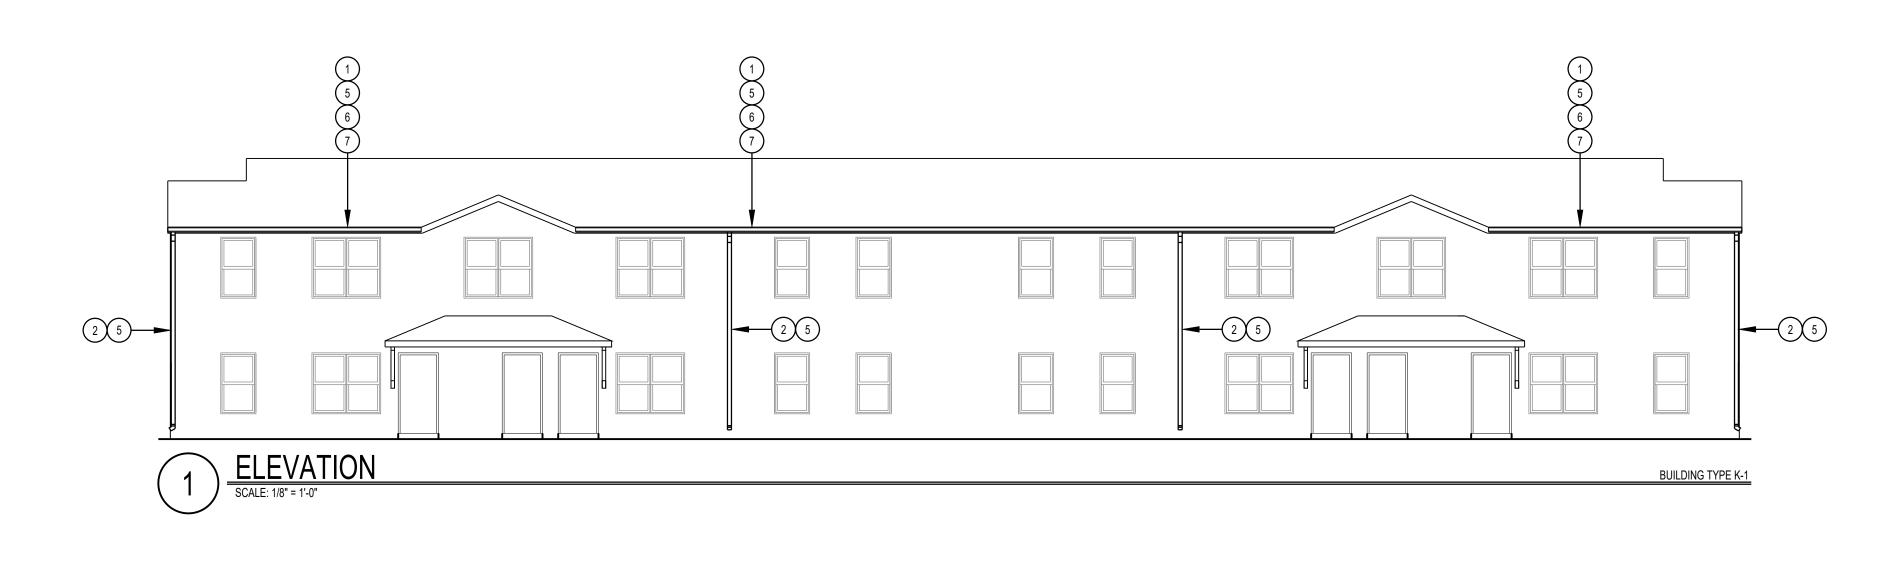

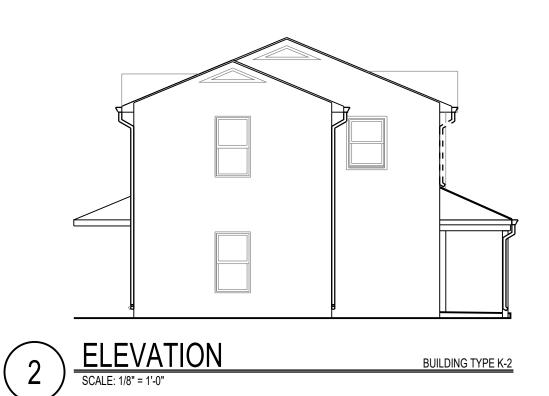


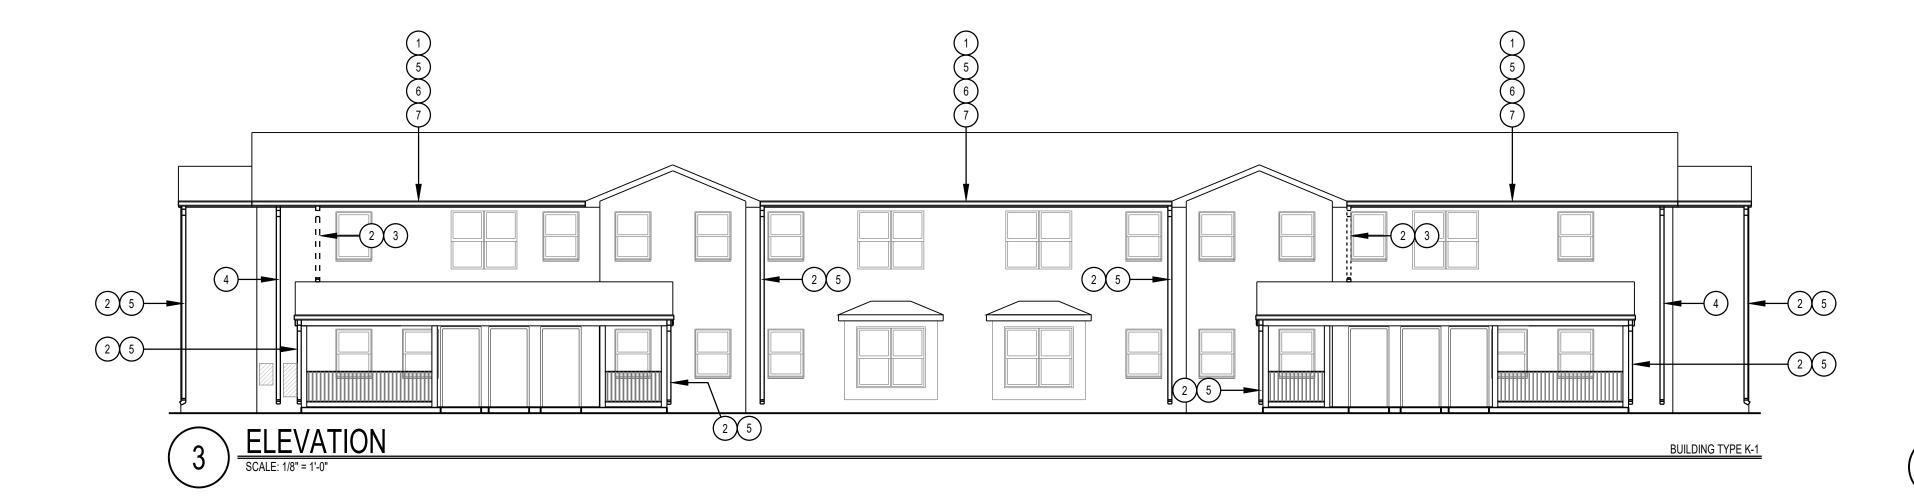

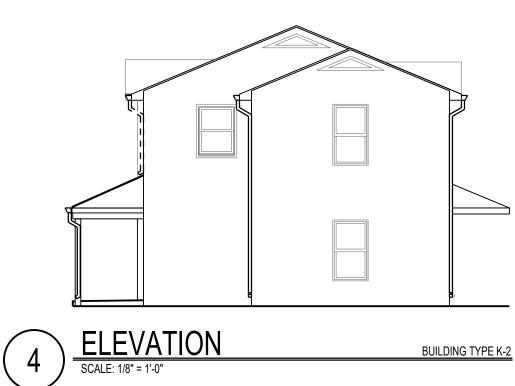

ELEVATION KEYNOTES

- 1 REUSE EXISTING GUTTER
- 2 REUSE EXISTING DOWNSPOUT
- 3 EXISTING DOWNSPOUT ELIMINATED IF ALTERNATE BID NO.1 IS ACCEPTED.
- NEW LOCATION OF NEW DOWNSPOUT IF ALTERNATE BID NO. 1 IS ACCEPTED.
- 5 <u>ALTERNATE BID NO.1:</u> PROVIDE NEW GUTTERS AND DOWNSPOUTS AS SPECIFIED.
- 6 <u>ALTERNATE BID NO.2:</u> PROVIDE GUTTER GUARD SYSTEM AS SPECIFIED IN EXISTING GUTTER.
- 7 ALTERNATE BID NO.3: PROVIDE GUTTER GUARD SYSTEM AS SPECIFIED IN NEW GUTTER.

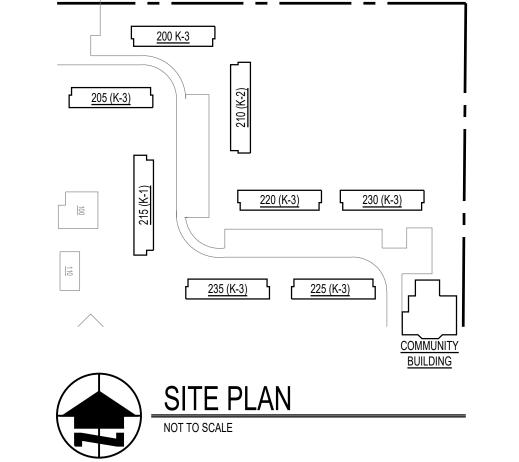


DESCRIPTION


BUILDING K-2 EXTERIOR ELEVATIONS


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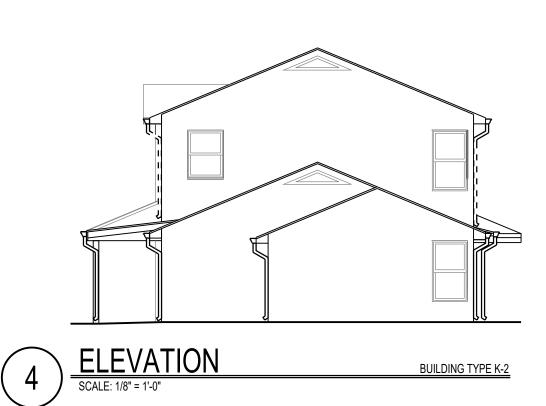
A2.02

OF



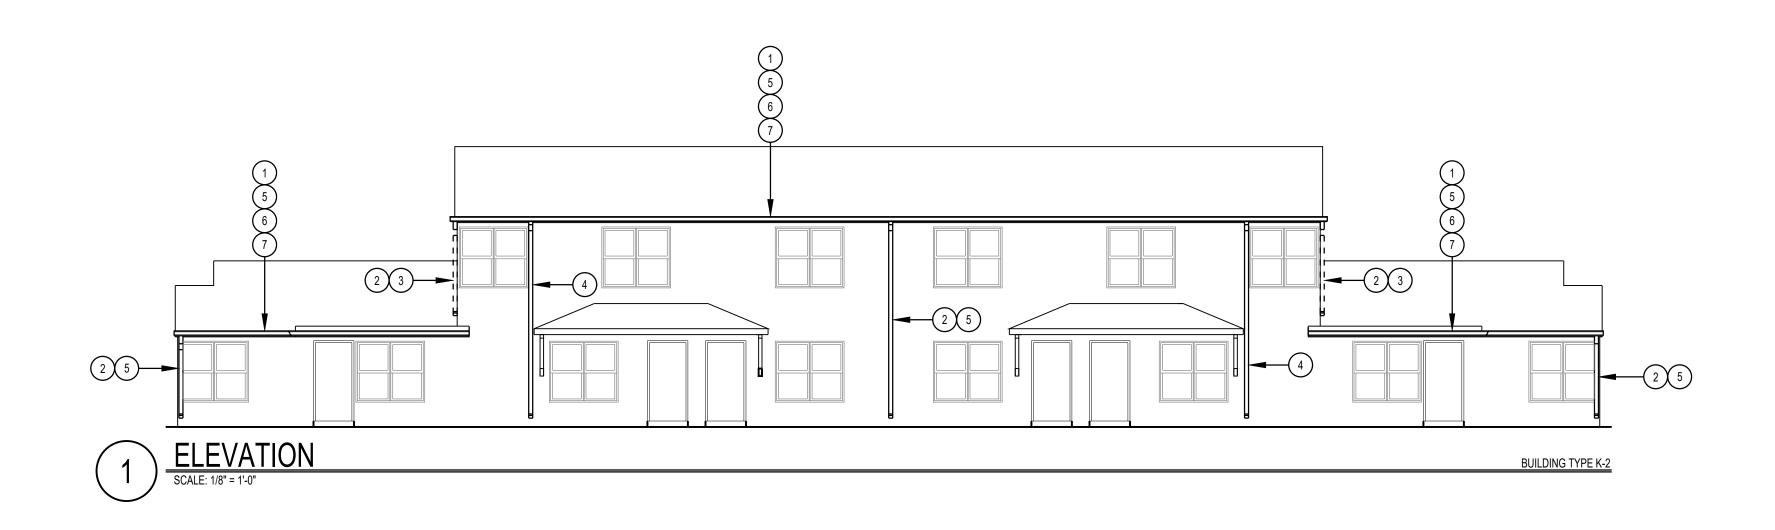


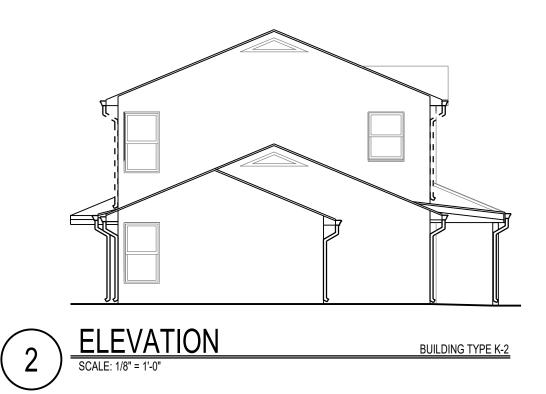

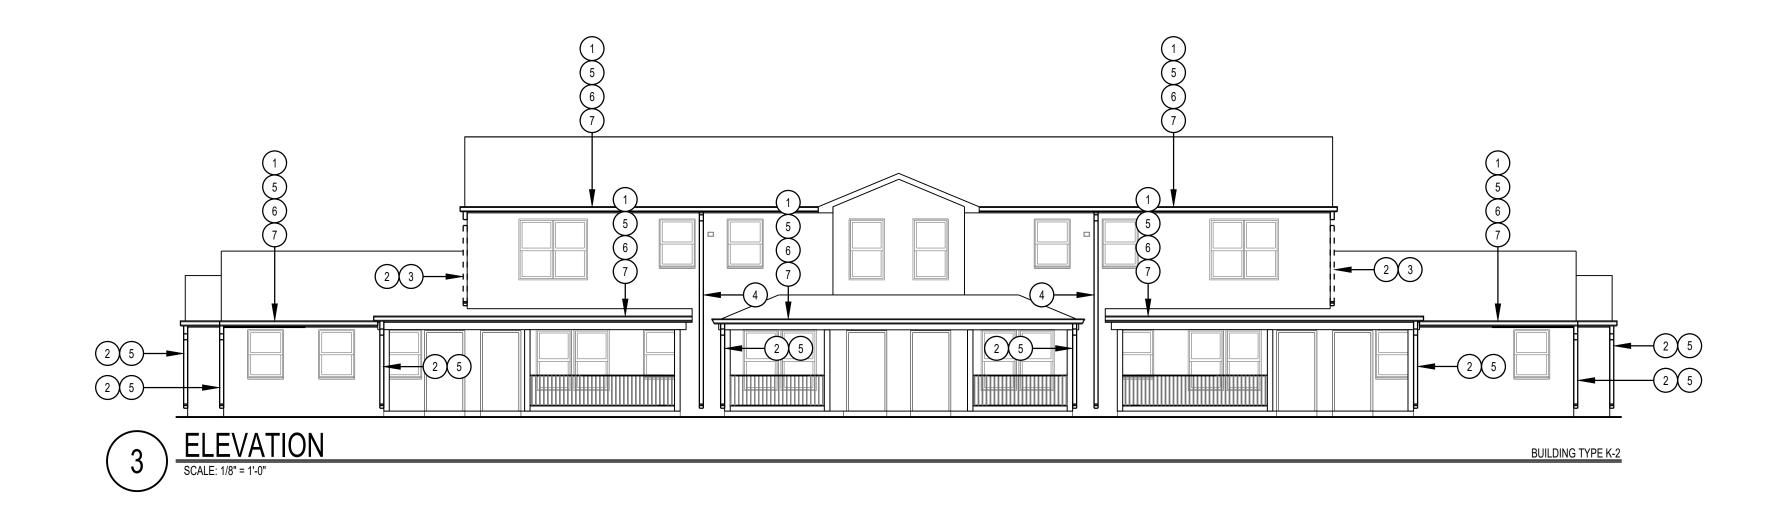

ELEVATION KEYNOTES

- 1 REUSE EXISTING GUTTER
- 2 REUSE EXISTING DOWNSPOUT
- 3 EXISTING DOWNSPOUT ELIMINATED IF ALTERNATE BID NO.1 IS ACCEPTED.
- NEW LOCATION OF NEW DOWNSPOUT IF ALTERNATE BID NO. 1 IS ACCEPTED.
- 5 <u>ALTERNATE BID NO.1:</u> PROVIDE NEW GUTTERS AND DOWNSPOUTS AS SPECIFIED.
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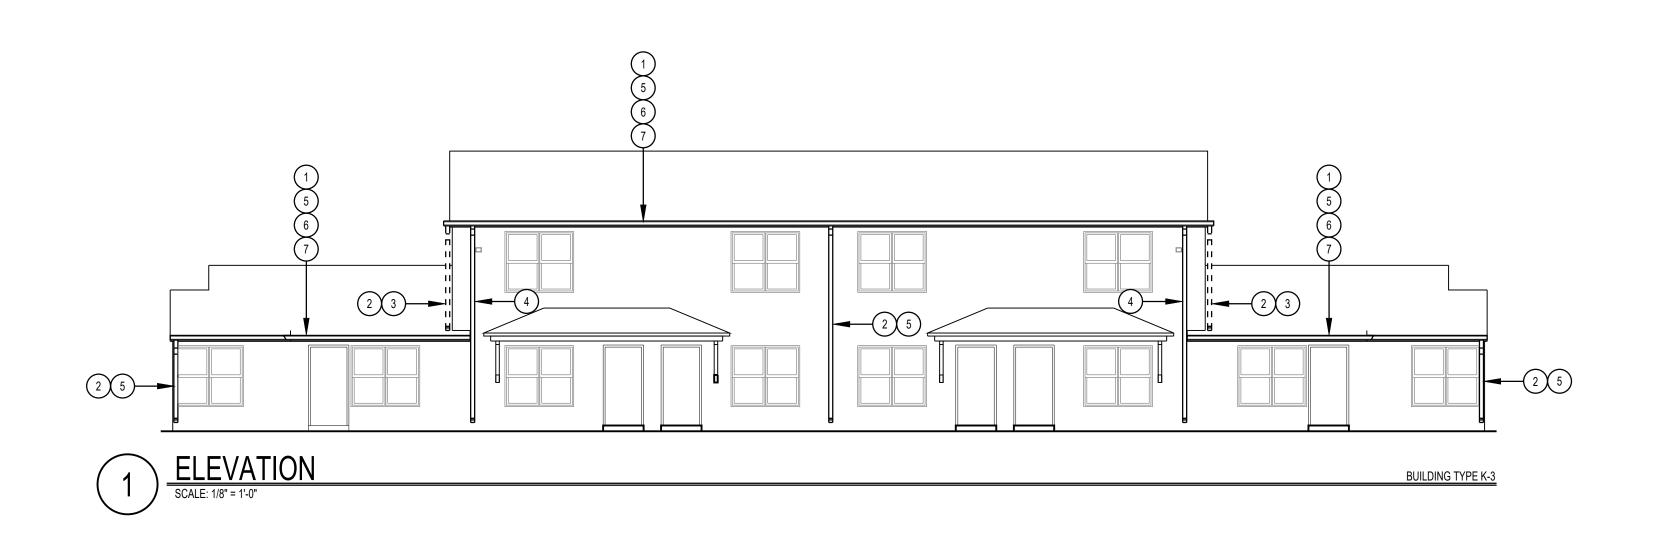
DESCRIPTION

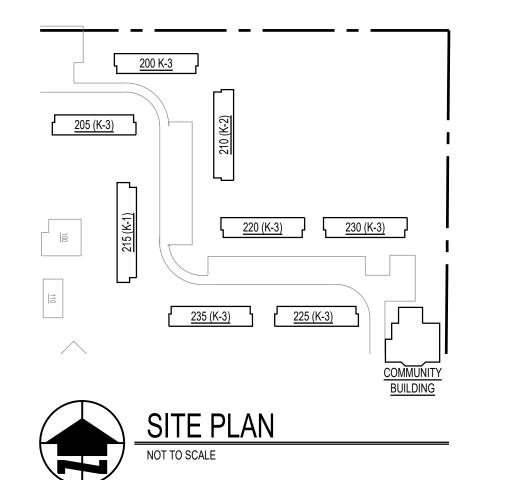
BUILDING K-3 EXTERIOR ELEVATIONS

SHEET NO.


A2.03

OF



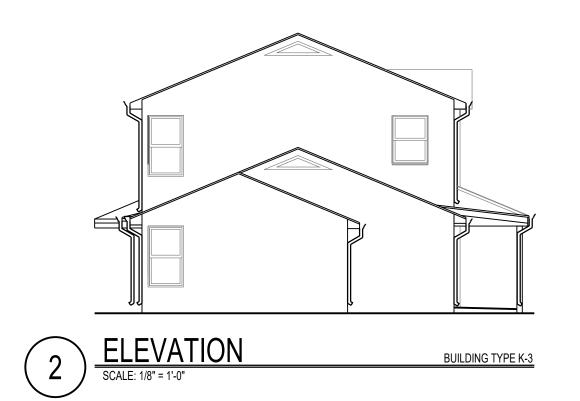




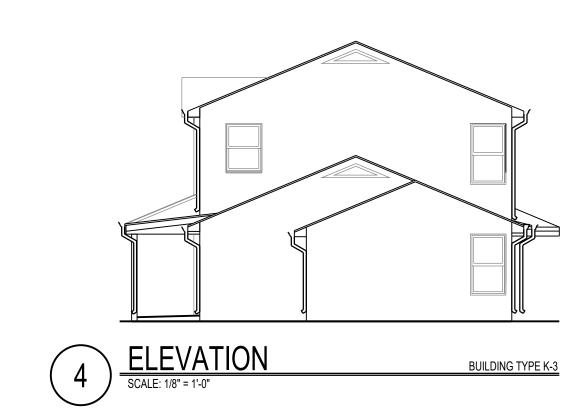

ELEVATION KEYNOTES

- 1 REUSE EXISTING GUTTER
- 2 REUSE EXISTING DOWNSPOUT
- 3 EXISTING DOWNSPOUT ELIMINATED IF ALTERNATE BID NO.1 IS ACCEPTED.
- NEW LOCATION OF NEW DOWNSPOUT IF ALTERNATE BID NO. 1 IS ACCEPTED.
- 5 <u>ALTERNATE BID NO.1:</u> PROVIDE NEW GUTTERS AND DOWNSPOUTS AS SPECIFIED.
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- 7 ALTERNATE BID NO.3: PROVIDE GUTTER GUARD SYSTEM AS SPECIFIED IN NEW GUTTER.

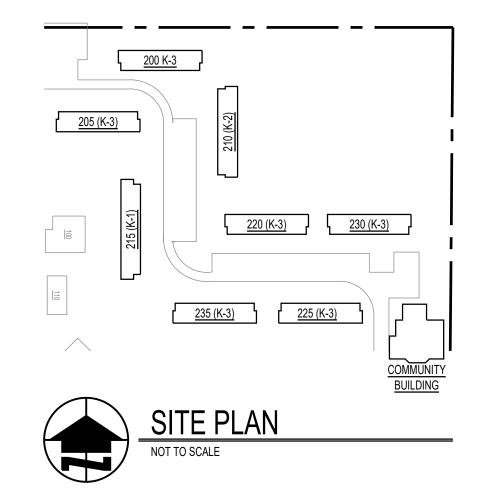

DESCRIPTION DETAILS

- FULLY ADHERED SINGLE

— EPDM MANUFACTURERS

STANDARD PREFINISHED METAL DRIP EDGE


— REUSE EXISTING GUTTERS AND DOWNSPOUTS


PLY EPDM ROOFING OVER 1/2" GYPSUM ROOF BOARD

SHEET NO.

A5.01

OF

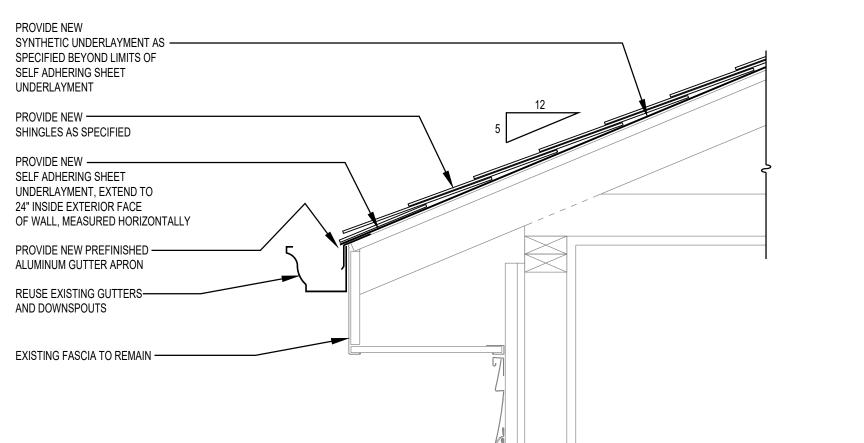

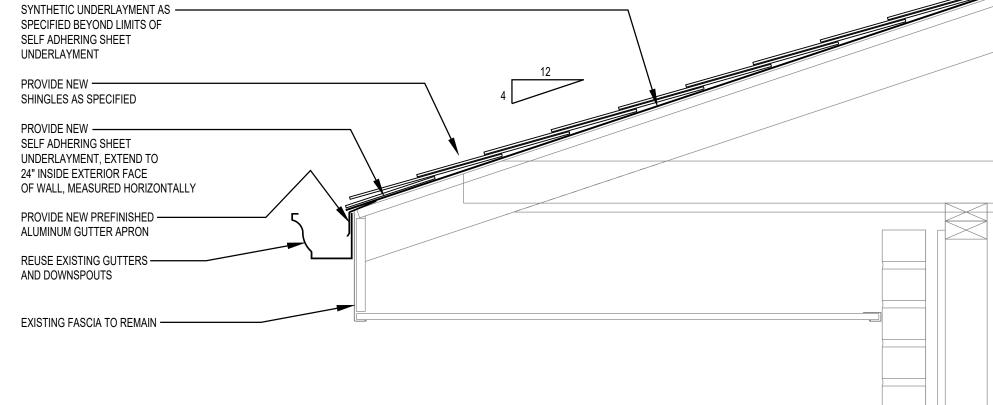

ROOF EDGE

PROVIDE NEW



PROVIDE NEW -SHINGLES AS SPECIFIED

SELF ADHERING SHEET

PREFINISHED METAL DRIP

EXISTING METAL FASCIA -


EXISTING VINYL SIDING -

TO REMAIN


TO REMAIN

UNDERLAYMENT EXTENDS TO 24" INSIDE EXTERIOR FACE OF WALL UNLESS OTHERWISE NOTED


PROVIDE NEW

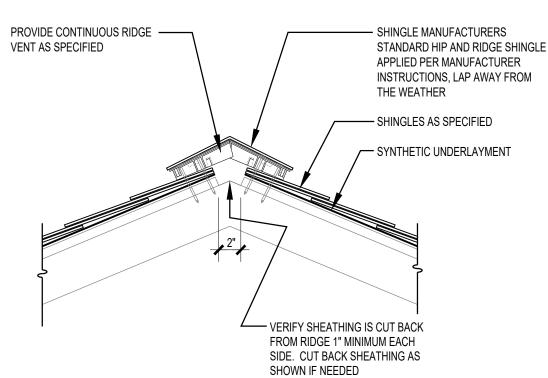

RIDGE VENT SECTION

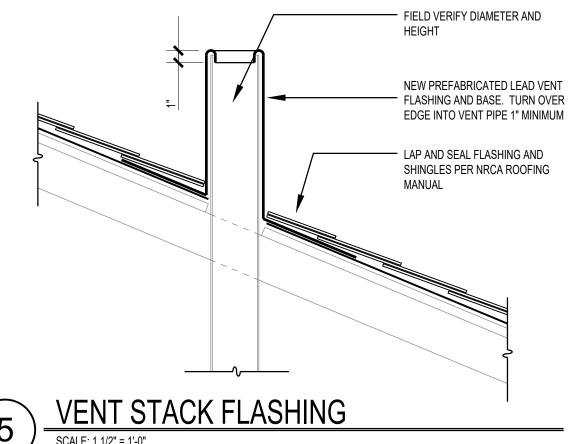

PROVIDE NEW SYNTHETIC UNDERLAYMENT AS -SPECIFIED BEYOND LIMITS OF SELF ADHERING SHEET UNDERLAYMENT PROVIDE NEW —— SHINGLES AS SPECIFIED PROVIDE NEW ----SELF ADHERING SHEET UNDERLAYMENT, EXTEND TO 24" INSIDE EXTERIOR FACE OF WALL, MEASURED HORIZONTALLY PROVIDE NEW PREFINISHED ALUMINUM GUTTER APRON EXISTING FASCIA TO REMAIN —

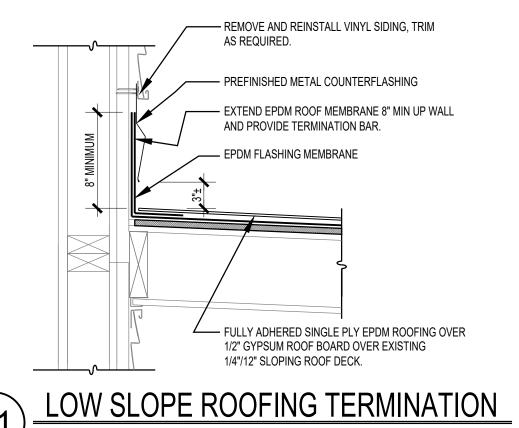

SECTION AT ROOF SLOPE TRANSITION

- REMOVE AND REINSTALL VINYL SIDING, TRIM

— PREFINISHED METAL COUNTERFLASHING


AND PROVIDE TERMINATION BAR.


- EPDM FLASHING MEMBRANE


WALL TO FLAT ROOF TERMINATION


- EXTEND EPDM ROOF MEMBRANE 8" MIN UP WALL

AS REQUIRED.

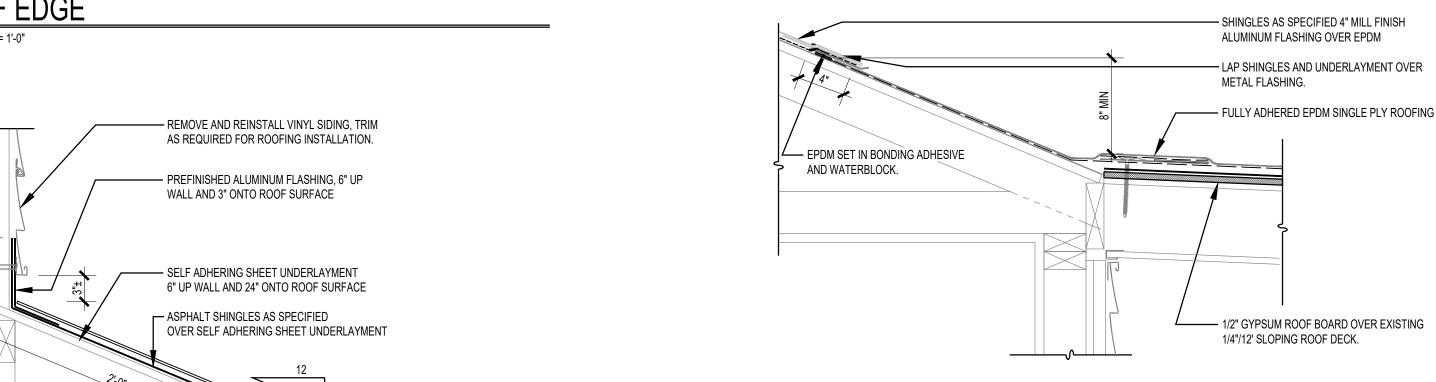

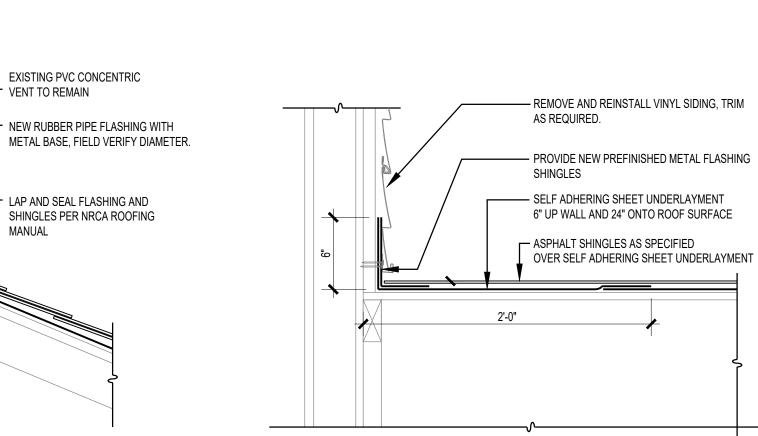

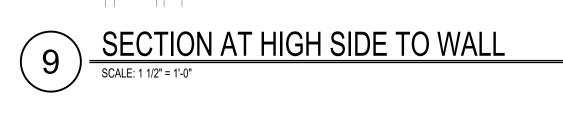

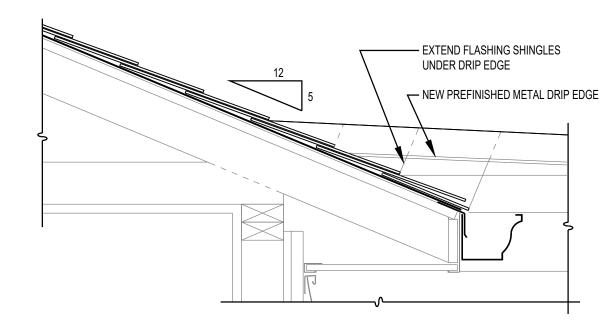

SECTION AT ROOF OFFSET

SCALE: 1 1/2" = 1'-0"

EXISTING PVC CONCENTRIC

NEW RUBBER PIPE FLASHING WITH

LAP AND SEAL FLASHING AND

SHINGLES PER NRCA ROOFING

VENT TO REMAIN

MANUAL





SPECIFIED BEYOND LIMITS OF
SELF ADHERING SHEET
UNDERLAYMENT

PROVIDE NEW
SHINGLES AS SPECIFIED

PROVIDE NEW
SELF ADHERING SHEET
UNDERLAYMENT, EXTEND TO
24" INSIDE EXTERIOR FACE
OF WALL, MEASURED HORIZONTALLY

PROVIDE NEW PREFINISHED
ALUMINUM GUTTER APRON

8CALE: 1 1/2" = 1'-0"

PROVIDE NEW
SHINGLES AS SPECIFIED

PROVIDE NEW
SELF ADHERING SHEET
UNDERLAYMENT EXTENDS TO
24" INSIDE EXTERIOR FACE
OF WALL UNLESS OTHERWISE NOTED

PROVIDE NEW
PREFINISHED METAL DRIP
EDGE

EXISTING METAL FASCIA
TO REMAIN

EXISTING VINYL SIDING
TO REMAIN

RAKE SECTION

SCALE: 1 1/2" = 1'-0"

HOUSING AUTHORITY OF HENRY COUNTY

SHINGLE ROOFING REPLACEMENT

IL9-1 FAIRVIEW APARTMENTS, KEWANEE, IL

DESCRIPTION

DETAILS

SHEET NO.

A5.02

OF